

ABN 68 300 116 092

PLANNING APPLICATION FORM

Section 57 & 58

	OFFICE	USE ONLY	
Application Number: [OA 2025 / 50	Date: 03.	09.2025
PID: 6436147	Zone: General	Zone: General Industrial Permitted or Di	
	DEVELOPMENT A	PPLICATION DETA	ILS
Applicant Name:	En ala sada a Disa Disa	1.4.1	

	DEVELOPMI	ENT APPLIC	ATIC	ON DETA	AILS		
Applicant Name:	Engineering Plus Pty Ltd						
Location/Address:	108 Bell Bay R	oad, Bell E	Bay 7	ΓAS 725	53		
Title Reference:	9210 /4						
Existing Development/Use: (describe the way the land is used now)	Commercial						
Development Type:	New dwelling □ Outbuilding ■ Addition/extension □ Fencing ■ Demolition □ Signage □ Subdivision □ Change of use □ Other □						
Description/Use:	Proposed Shed						
New floor area:	148.26 m ² Total floor area:		374	1.33 m²	New building	ng height:	4.8 m
Water Supply:	TasWater □ Tank ☑	Wastewate	er: T	asWater	□ On-Site	Wastewater	System ☑
Driveway/Vehicle Crossover: Existing ■ Proposed □ Alteration Required □ Contact Council's engineering department for details on crossover construction							
Does the application include Crown Land or access via a Crown Access License?		Yes \(\triangle \) No \(\triangle \) If 'yes', please provide Crown consent to lodge the planning application in accordance with section 52 (1B) of the Land Use Planning and Approvals Act 1993.				ction 52 (1B)	
	SUBDIVISION N/A 🖸				N/A ☑		
Evicting Leto.							

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	SUBDIVISION		N/A ☑
Existing Lots:	Number of total lots pr	oposed:	

COMMERCIAL/INDUSTRIAL N/A				
Existing business and/or proposed business description:	crane hire services			
	Weekdays (Mon – Fri)	24 hours / 7 days	То	
Hours of Operation:	Saturday		То	
	Sunday		То	
Signage:	Yes □ No □	If 'yes', please provide details with application.		with application.
Existing no. of employees:	5	No. of employees 10 (proposed):		10
Parking spaces (existing)	10	Parking spaces (proposed)		-



RESULT OF SEARCH

RECORDER OF TITLES

Issued Pursuant to the Land Titles Act 1980



SEARCH OF TORRENS TITLE

VOLUME	FOLIO
9210	4
EDITION	DATE OF ISSUE
3	22-Mar-2019

SEARCH DATE : 07-Aug-2025 SEARCH TIME : 12.08 PM

DESCRIPTION OF LAND

Parish of CRANBOURNE, Land District of DORSET

Lot 4 on Sealed Plan 9210

EXCEPTING THEREOUT so much thereof as lies below the depth of fifty feet from the surface thereof saving as to wells and springs

Excepting thereout AND ALSO EXCEPTING THEREOUT the property in all gold silver copper tin and other metals ore minerals and other substances containing metals and in all coal and mineral oil and in all gems and precious stones in or on the said land within described

Derivation : Part of Lot 280 Gtd to W E Lawrence Prior CT 3635/50

SCHEDULE 1

M724696 TRANSFER to

Registered 22-Mar-2019 at noon

SCHEDULE 2

Reservations and conditions in the Crown Grant if any

SP 9210 EASEMENTS in Schedule of Easements

SP 9210 FENCING COVENANT in Schedule of Easements

UNREGISTERED DEALINGS AND NOTATIONS

No unregistered dealings or other notations




FOLIO PLAN

RECORDER OF TITLES



Issued Pursuant to the Land Titles Act 1980

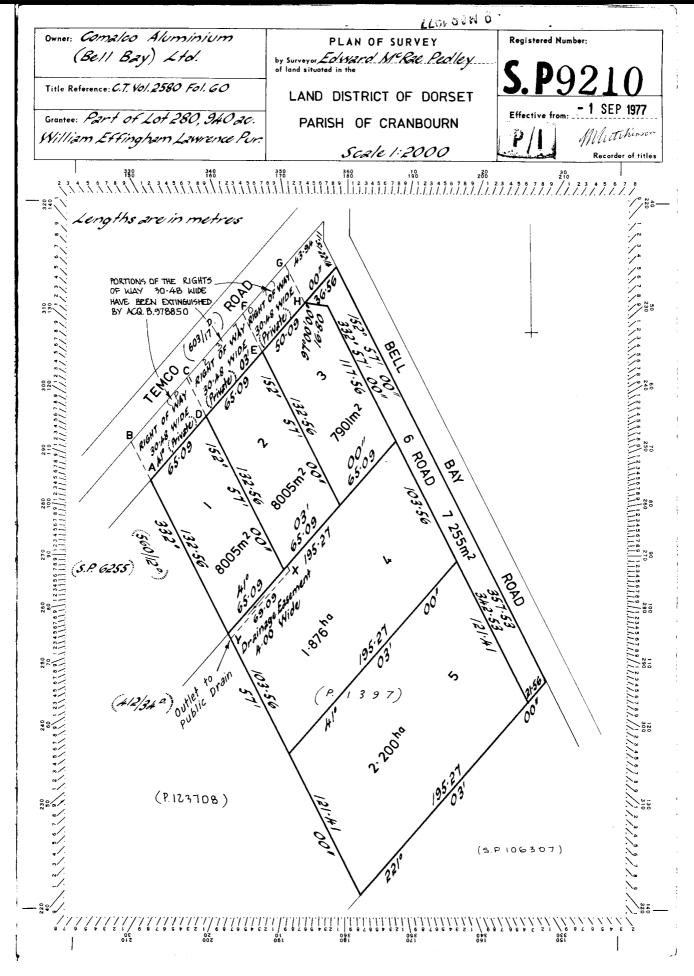

Search Date: 07 Aug 2025

Search Time: 12:08 PM

Volume Number: 9210

Revision Number: 03

Page 1 of 1



DRAWING SCHEDULE

A00 COVER PAGE A01 LOCALITY PLAN A02 SITE PLAN A03 LANDSCAPE PLAN A04 CONSTRUCTION PLAN A05 FLOOR PLAN A06 **ELEVATIONS #1 ELEVATIONS #2** A07 80A 3D PERSPECTIVE #1 A09 3D PERSPECTIVE #2 A10 3D PERSPECTIVE #3 A11 3D PERSPECTIVE #4 A12 3D PERSPECTIVE #5 A13 3D PERSPECTIVE #6 A14 3D PERSPECTIVE #7

PROJECT INFORMATION

BUILDING DESIGNER: GRANT JAMES PFEIFFER

ACCREDITATION No: CC2211T

ZONE: 19.0 GENERAL INDUSTRIAL ZONE

BUILDING CLASS: CLASS 7B LAND TITLE REFERENCE NUMBER: 9210/4

DESIGN WIND SPEED:

SOIL CLASSIFICATION:

ASSUME "N2"

ASSUME "H1"

CLIMATE ZONE: 7
BUSHFIRE-PRONE BAL RATING: N/A
ALPINE AREA: N/A
CORROSION ENVIRONMENT: SEVERE

FLOODING: NO LANDSLIP: NO

DISPERSIVE SOILS: UNKNOWN SALINE SOILS: UNKNOWN

SAND DUNES:

MINE SUBSIDENCE:

LANDFILL:

NO

GROUND LEVELS: REFER PLAN

ORG LEVEL: 75mm ABOVE GROUND LEVEL

PROPOSED SHED


I. & D. PFEIFFER 108 BELL BAY RD BELL BAY TAS 7253

GEORGE TOWN COUNCIL

ISSUED FOR DEVELOPMENT APPROVAL

DEVELOPMENT AREA			
Name	Area		
EXISTING TEMPORARY TRANSPORTABLE CONTAINER - SITE OFFICE	36.00 m ²		
PROPOSED SHED	148.26 m²		
TEMPORARY CONTAINERS	29.89 m²		
TEMPORARY TRANSPORTABLE - SITE OFFICE	121.75 m²		
TEMPORARY TRANSPORTABLE CONTAINER - SITE OFFICE (1)	38.42 m²		

374.33 m²

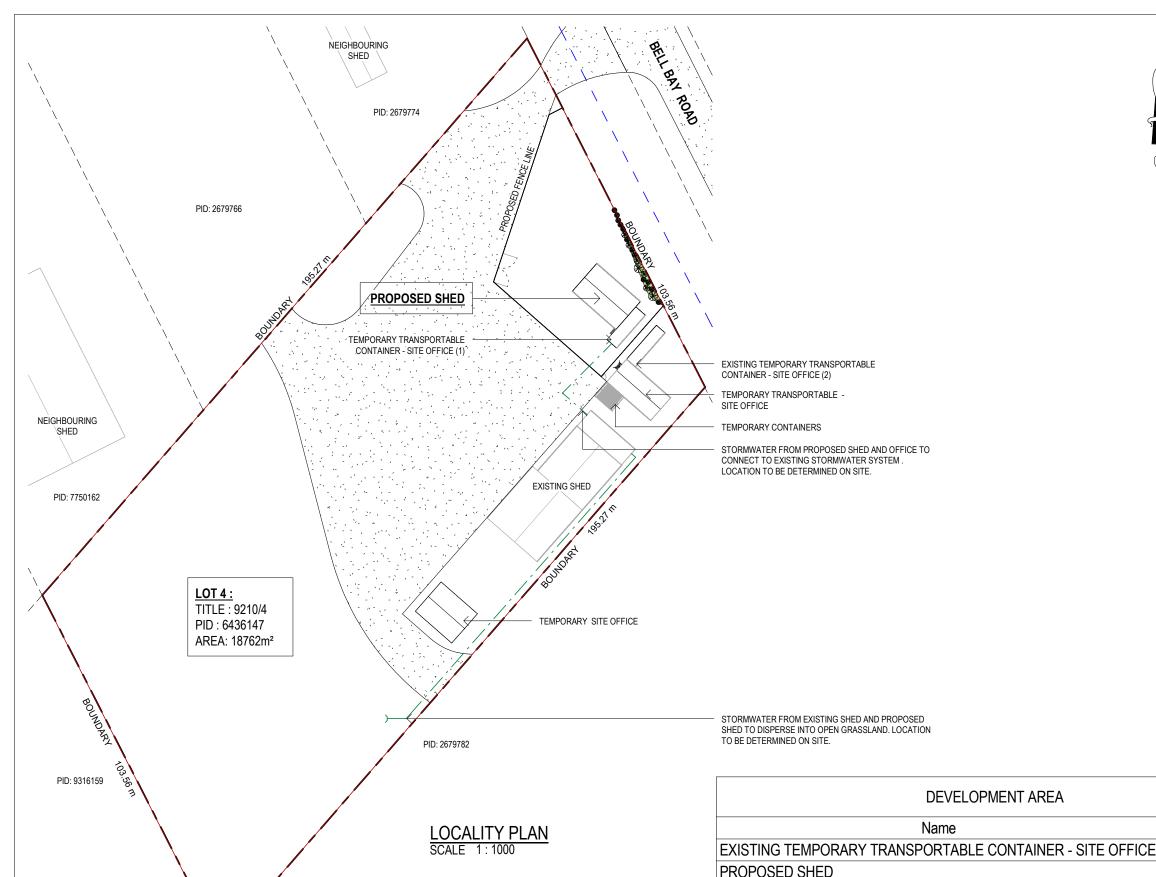

TEMPORARY CONTAINERS

TEMPORARY TRANSPORTABLE - SITE OFFICE

TEMPORARY TRANSPORTABLE CONTAINER - SITE OFFICE (1)

DEVELOPMENT APPROVAL

DEVELOPMENT APPROVAL

ISSUED FOR REVIEW

Rev: Amendment:



<u>LEGEND</u>				
	SEWER			
	WATER			
	STORMWATER			

DRAINAGE
ALL DRAINAGE WORK SHOWN IS PROVISIONAL ONLY AND IS SUBJECT TO AMENDMENT TO COMPLY WITH THE REQUIREMENTS OF THE LOCAL AUTHORITIES. ALL WORK IS TO COMPLY WITH THE REQUIREMENTS OF NATIONAL PLUMBING AND DRAINAGE CODE AS3500 AND MUST BE CARRIED OUT BY A LICENCED TRADESMAN ONLY.

STORMWATER FROM PROPOSED SHED TO BE DIRECTED INTO EXISTING STORMWATER SYSTEM TO LOCAL COUNCIL REQUIREMENTS &

R.F.I NOTES : 6.0 ASSESSMENT OF AN APPLICATION FOR USE OR DEVELOPMENT

- ALL CURRENT USES AND ACTIVITIES THE CURRENT USE FOR 108, BELL BAY ROAD IS AS A PLACE FOR CRANE HIRE SERVICES. THE PROPOSED SHED WILL BE PART OF THE BUSINESS EXPANSION.
- AN ESTIMATE OF THE AVERAGE DAILY AND ANNUAL VEHICLE MOVEMENTS; AND TYPES OF VEHICLES ACCESSING THE SITE. AT AN AVERAGE OF 15 - 20 VEHICLES DAILY, IT
- WILL BRING UP TO AN ESTIMATE OF 4680 ANNUAL VEHICLE MOVEMENTS
- THE TYPES OF VEHICLES ACCESSING THE

CRANES AND STAFF/CUSTOMER VEHICLES.

- NUMBER OF STAFF CURRENTLY EMPLOYED 5 EXISTING STAFFS THAT ARE CURRENTLY WORKING ON SITE.

- THE CURRENT USE OF THE EXISTING BUILDING AND THE INTENDED FUTURE USE. THE CURRENT USE OF THE EXISTING BUILDING IS FOR MAINTENANCE SHED AND WILL STILL BE THE SAME IN THE FUTURE

R.F.I UPDATES

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Client: I. & D. PFEIFFER Project: PROPOSED SHED

Address: 108 BELL BAY ROAD,

Office: 6331 7021

Area

36.00 m²

148.26 m²

29.89 m²

121.75 m²

38.42 m²

374.33 m²

Date Drawn: 08.08.25

Scale: As Shown @ A3

Accredited Building Designer

Drawn: R. Hall

Checked: R. Hall Approved: J. Pfeiffer

08.08.25 R.H Designer Name: J.Pfeiffer

Date: Int: Accreditation No: CC2211T

22.09.25 J.C

15.08.25 J.C

BELL BAY 7253 TAS ENGINEERING

info@engineeringplus.com.au


PLUS BUILDING DESIGN
PROJECT MANAGEMENT
CIVIL/STRUCTURAL ENGIN

Drawing No:


2025-220 A01/A14

Rev



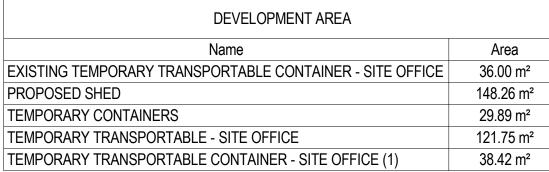

374.33 m²

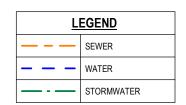



Date Drawn: 08.08.25

Scale: As Shown @ A3

Drawn: R. Hall

Checked: R. Hall Approved: J. Pfeiffer

22.09.25 J.C

15.08.25 J.C

DEVELOPMENT APPROVAL

ISSUED FOR REVIEW

Rev: Amendment:

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Client: I. & D. PFEIFFER Project: PROPOSED SHED

Address: 108 BELL BAY ROAD,


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PROJECT MANAGEMENT
CIVIL/STRUCTURAL ENGI info@engineeringplus.com.au


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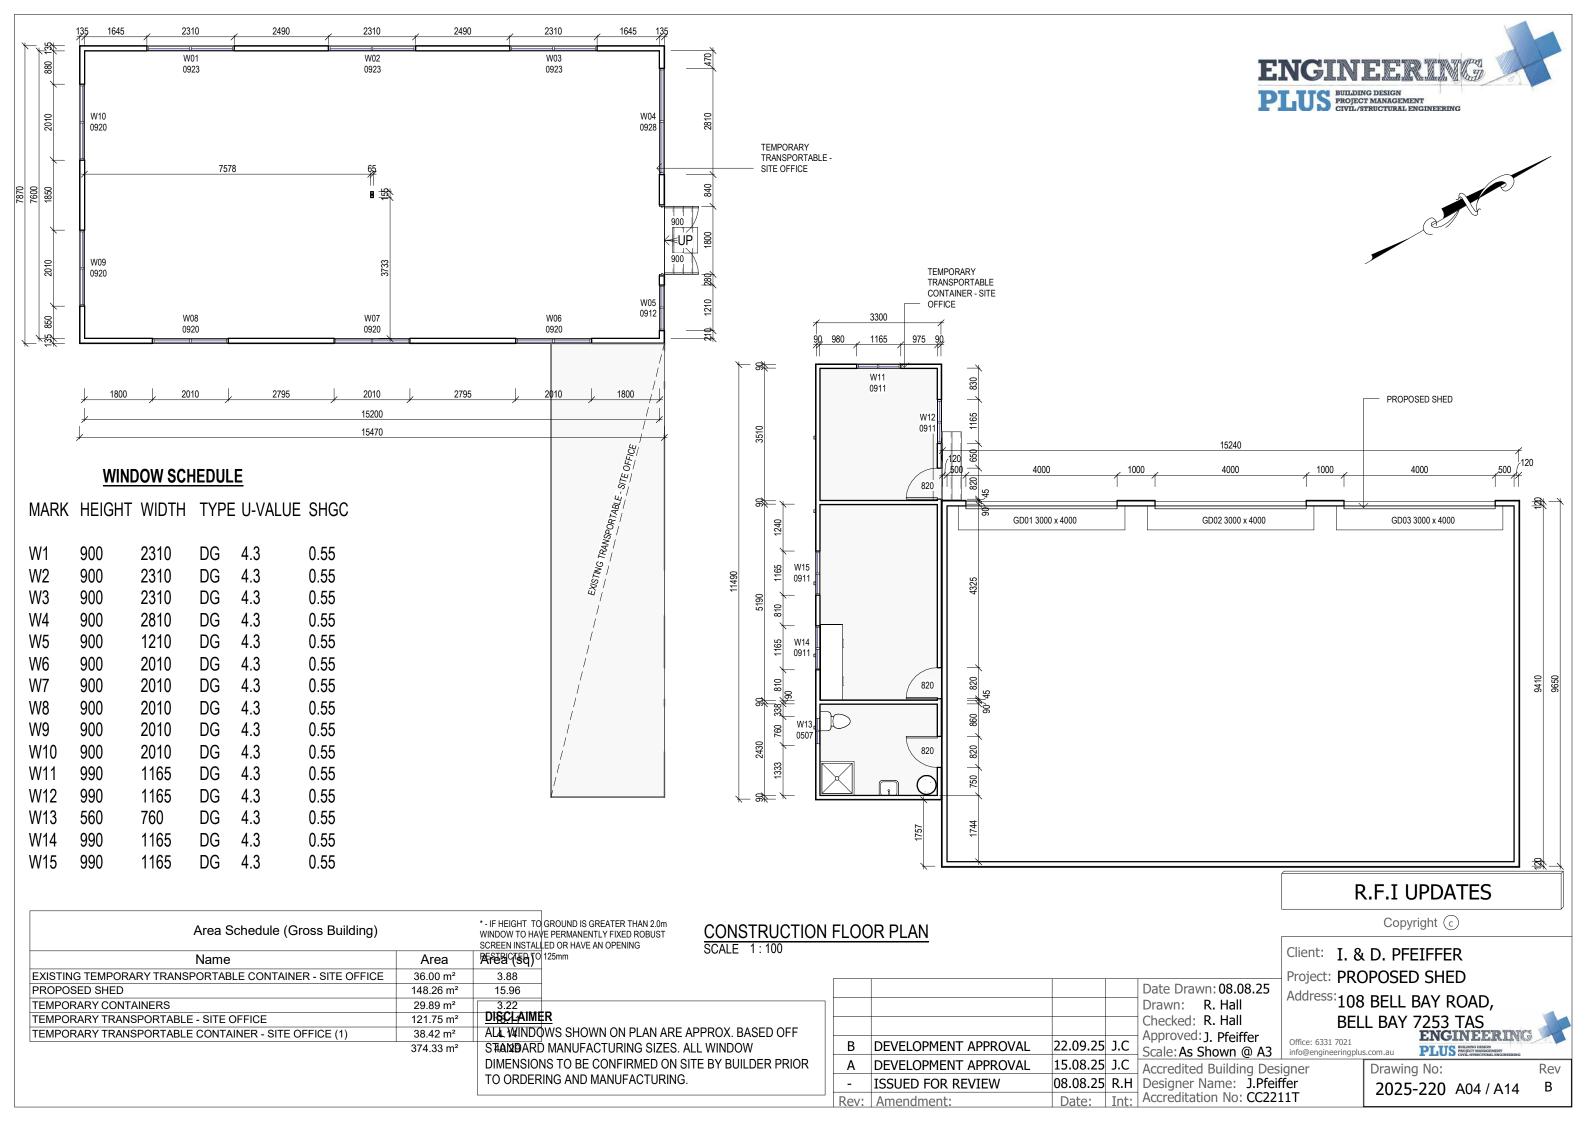
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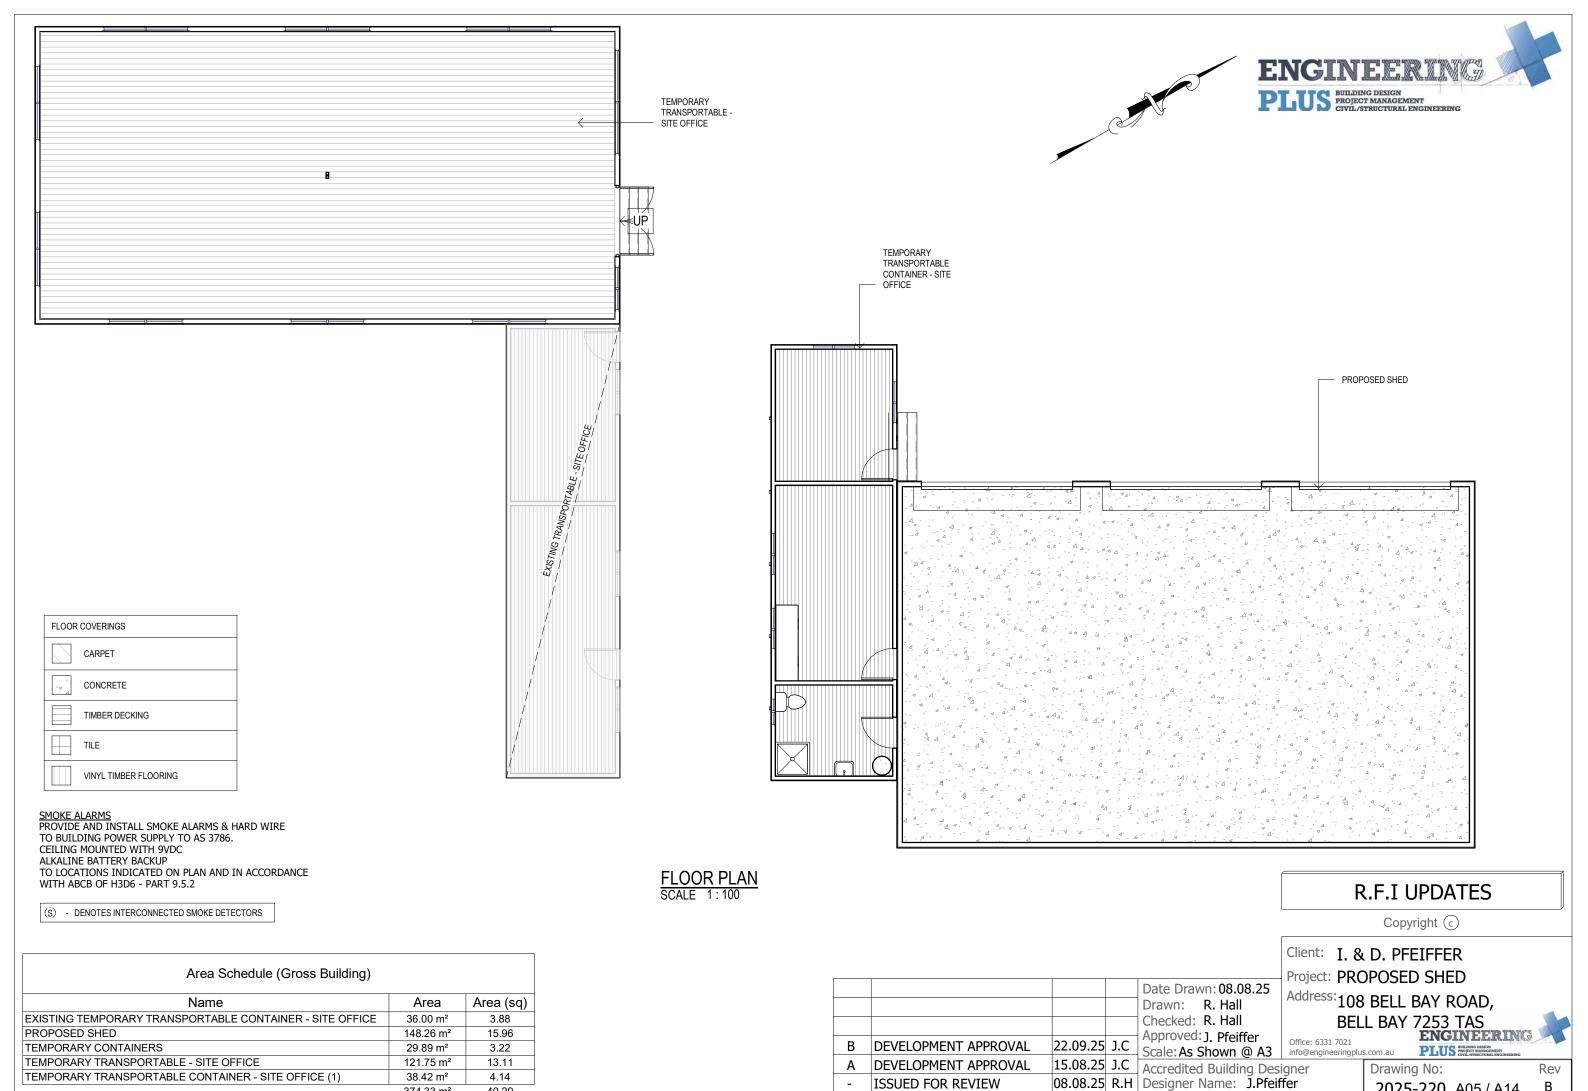
Drawing No: Accredited Building Designer 08.08.25 R.H Designer Name: J.Pfeiffer 2025-220 A02/A14 Date: Int: Accreditation No: CC2211T



EXISTING SHED



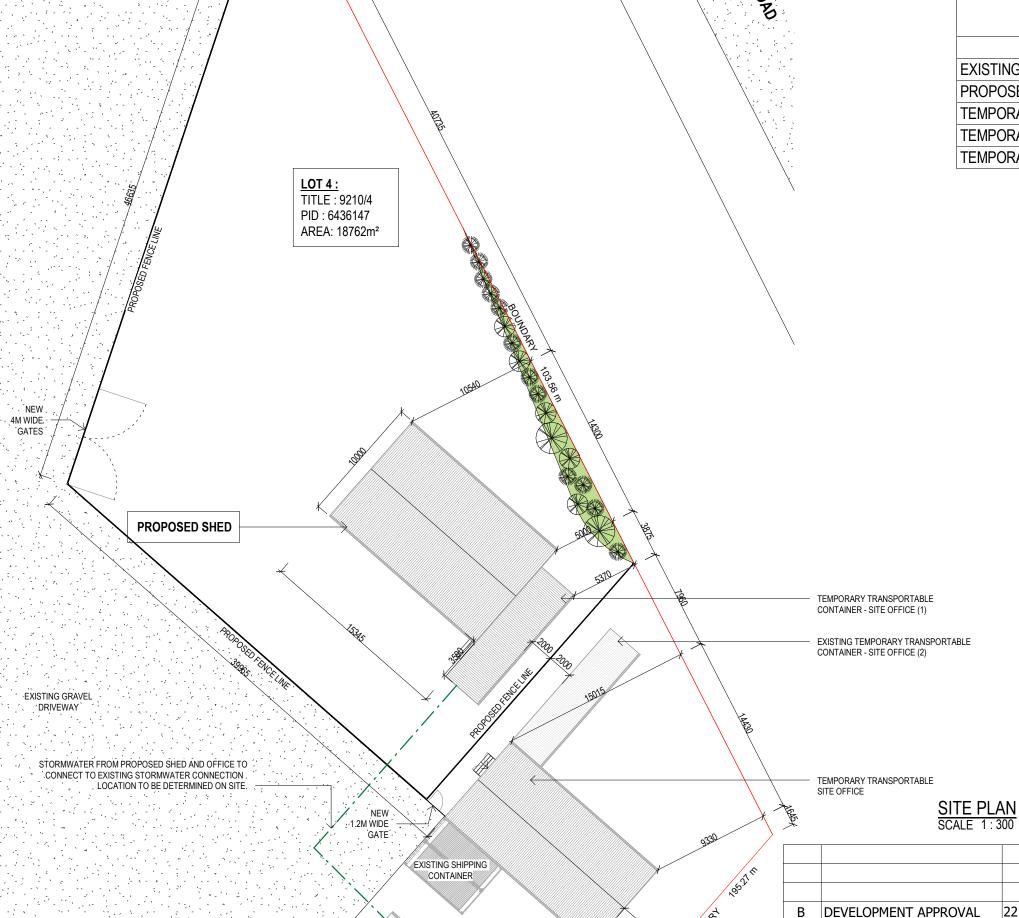

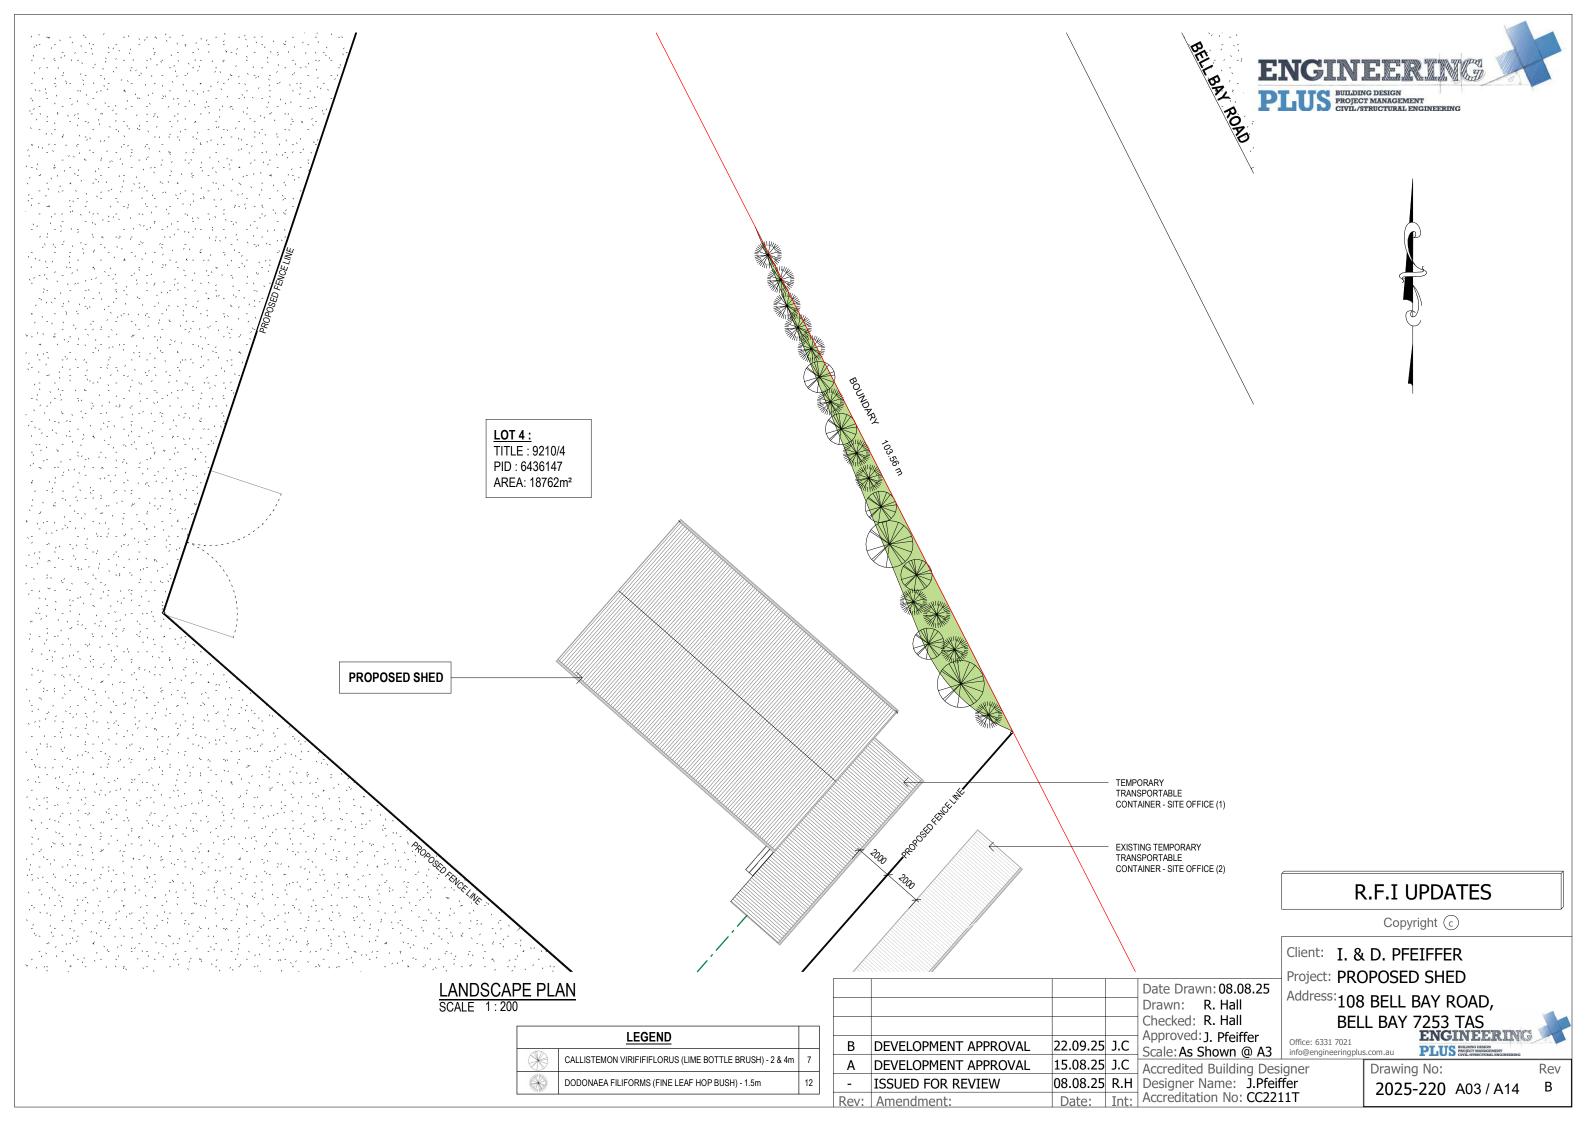

Rev: Amendment:

374.33 m²

40.29


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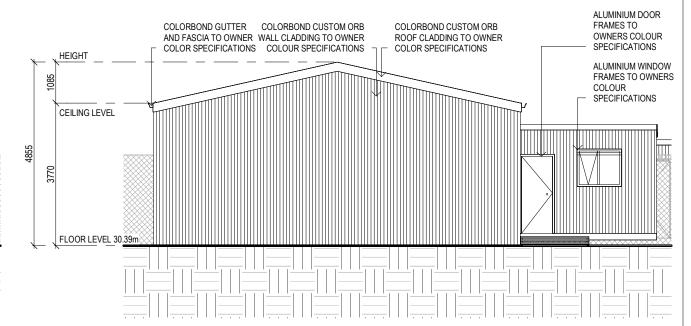
Date: Int: Accreditation No: CC2211T

SOFFIT / EAVE LINED WITH 'HARDIFLEX' CEMENT SHEETING


- TRIMMERS LOCATED WITHIN 1200 MM OF EXTERNAL CORNERS TO BE SPACED @ 500 MM CENTERS, REMAINDER OF SHEET 700 MM CENTERS
- FASTENER / FIXINGS WITHIN 1200 MM OF EXTERNAL CORNERS @ 200 MM CENTERS, REMAINDER OF SHEET 300 MM CENTERS





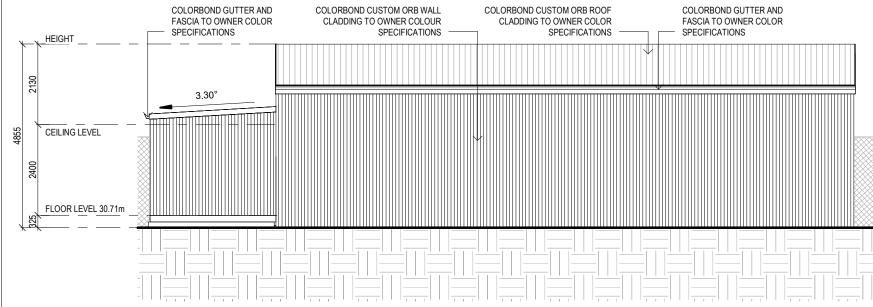

EAST ELEVATION (PROPOSED SHED) SCALE 1:100

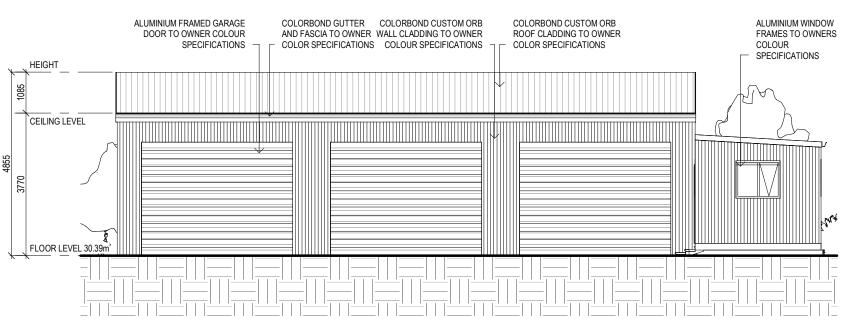

NORTH ELEVATION (PROPOSED SHED)

COLORBOND GUTTER AND FASCIA TO OWNER COLORBOND CUSTOM ORB ROOF CLADDING TO OWNER ALUMINIUM WINDOW COLORBOND CUSTOM ORB FRAMES TO OWNERS WALL CLADDING TO OWNER **COLOR SPECIFICATIONS** COLOR SPECIFICATIONS COLOUR COLOUR SPECIFICATIONS SPECIFICATIONS **HEIGHT** CEILING LEVEL FLOOR LEVEL 30.71

WEST ELEVATION (PROPOSED SHED)

POWDER COATED ALUMINIUM WINDOW & DOOR FRAMES, UNLESS OTHERWISE NOTED.

TASMANIAN OAK REVEALS AND TRIMS. ALL FLASHING AND FIXINGS TO MANUFACTURERS SPECIFICATIONS.

GLAZING & FRAME CONSTRUCTION TO AS 2047 & AS 1288

SELECTED ALUMINIUM FRAMED WINDOWS - ABCB VOLUME 2 PART 8.3

ALL FIXINGS AND FLASHINGS TO MANUFACTURERS REQUIREMENTS

Date Drawn: 08.08.25 Drawn: R. Hall Checked: R. Hall Approved: J. Pfeiffer DEVELOPMENT APPROVAL 22.09.25 J.C Scale: As Shown @ A3 DEVELOPMENT APPROVAL 15.08.25 J.C Accredited Building Designer

ISSUED FOR REVIEW

Rev: Amendment:

Project: PROPOSED SHED Address: 108 BELL BAY ROAD,

08.08.25 R.H Designer Name: J.Pfeiffer

Date: Int: Accreditation No: CC2211T

SOUTH ELEVATION (PROPOSED SHED)

Office: 6331 7021 info@engineeringplus.com.a

ENGINEERING PLUS BUILDING DESIGN
PROJECT MANAGEMENT
GIVIL/STRUCTURAL ENGI

BELL BAY 7253 TAS

Client: I. & D. PFEIFFER

Drawing No:

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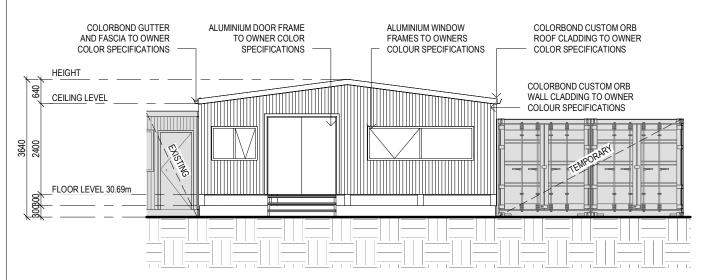
2025-220 A06 / A14

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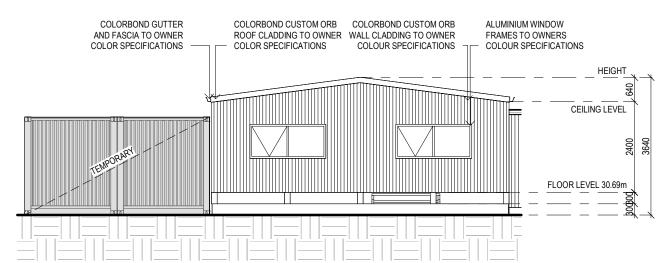
SOFFIT / EAVE LINED WITH 'HARDIFLEX' CEMENT SHEETING

- TRIMMERS LOCATED WITHIN 1200 MM OF EXTERNAL CORNERS TO BE SPACED @ 500 MM CENTERS, REMAINDER OF SHEET 700 MM CENTERS
- FASTENER / FIXINGS WITHIN 1200 MM OF EXTERNAL CORNERS @ 200 MM CENTERS, REMAINDER OF SHEET 300 MM CENTERS





NORTH ELEVATION (TRANSPORTABLE - SITE OFFICE)



SOUTH ELEVATION (TRANSPORTABLE - SITE OFFICE)


SELECTED ALUMINIUM FRAMED WINDOWS - ABCB VOLUME 2 PART 8.3

POWDER COATED ALUMINIUM WINDOW & DOOR FRAMES, UNLESS OTHERWISE NOTED.


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GLAZING & FRAME CONSTRUCTION TO AS 2047 & AS 1288

ALL FIXINGS AND FLASHINGS TO MANUFACTURERS REQUIREMENTS

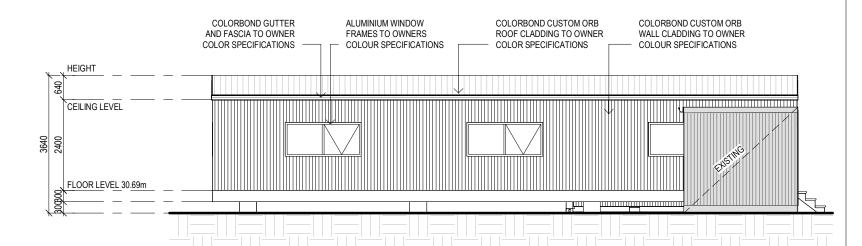

EAST ELEVATION (TRANSPORTABLE - SITE OFFICE)

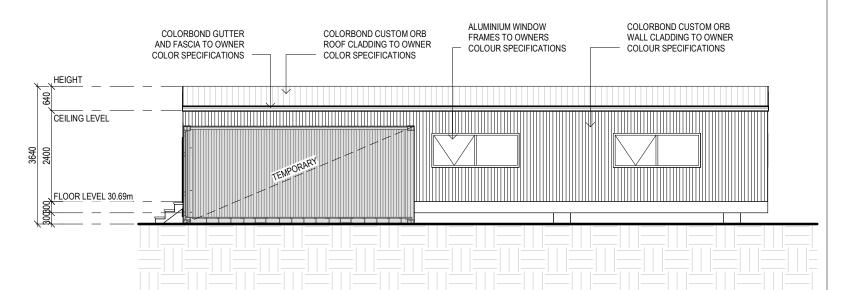

WEST ELEVATION (TRANSPORTABLE - SITE OFFICE)

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Address: 108 BELL BAY ROAD, **BELL BAY 7253 TAS**

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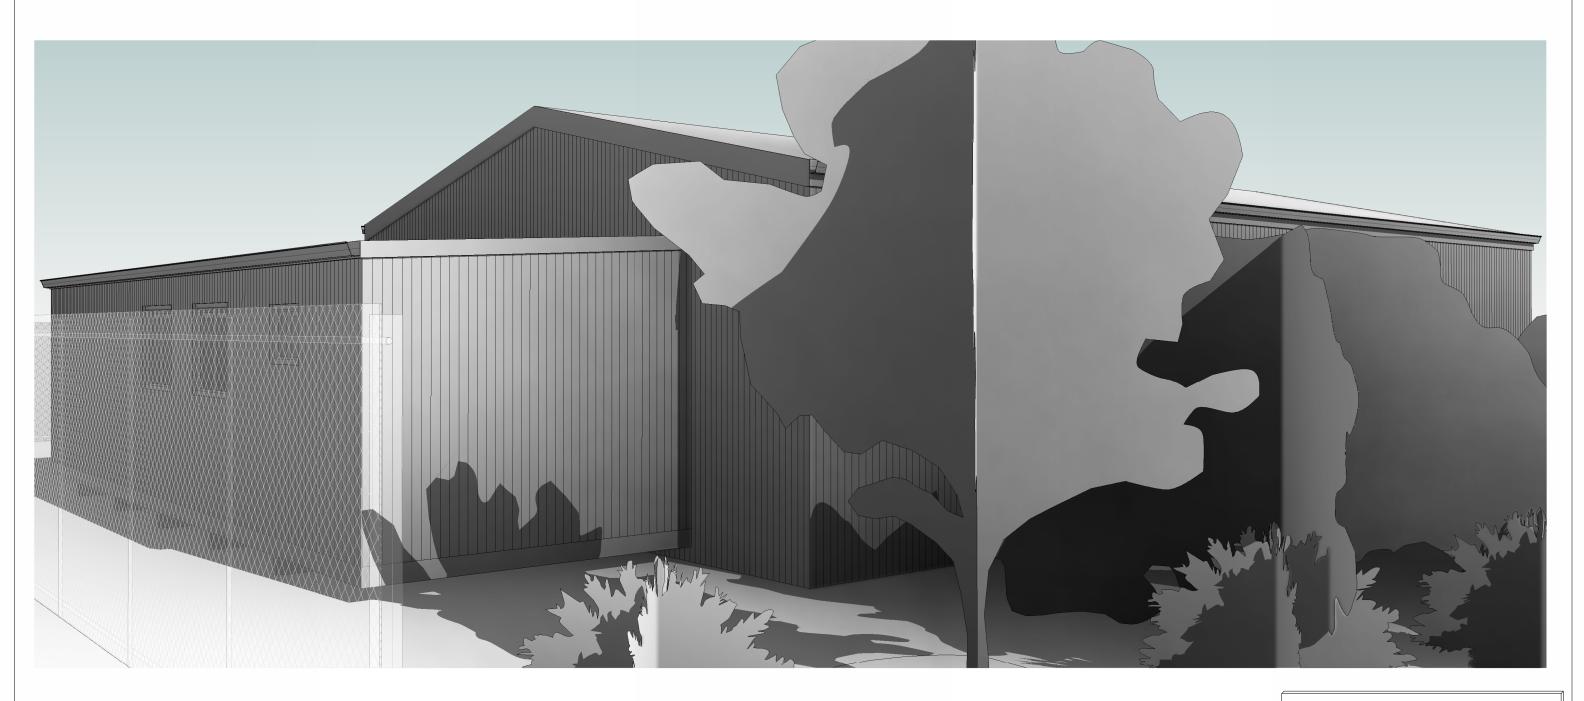
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Date Drawn: 08.08.25 Drawn: R. Hall Checked: R. Hall Approved: J. Pfeiffer DEVELOPMENT APPROVAL 22.09.25 J.C Scale: As Shown @ A3 DEVELOPMENT APPROVAL 15.08.25 J.C ISSUED FOR REVIEW Rev: Amendment:

Accredited Building Designer 08.08.25 R.H Designer Name: J.Pfeiffer Date: Int: Accreditation No: CC2211T

2025-220 A07/A14





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Client: I. & D. PFEIFFER

Project: PROPOSED SHED Date Drawn: 08.08.25

Drawn: R. Hall

DEVELOPMENT APPROVAL DEVELOPMENT APPROVAL

ISSUED FOR REVIEW

Rev: Amendment:

Address: 108 BELL BAY ROAD,

BELL BAY 7253 TAS
ENGINEERING
17021
eeringplus.com.au

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PLUS TRANSM

Checked: R. Hall
Approved: J. Pfeiffer
Scale: As Shown @ A3

15.08.25 J.C

08.08.25 R.H
Date: Int:

Drawn: K. Hall
Approved: J. Pfeiffer
Scale: As Shown @ A3


Office: 6331 7021
info@engineeringplus.com.au

Draw
Office: 6331 7021
info@engineeringplus.com.au

Draw
Accredited Building Designer
Designer Name: J.Pfeiffer
Accreditation No: CC2211T

202 Drawing No:

Rev 2025-220 A08 / A14

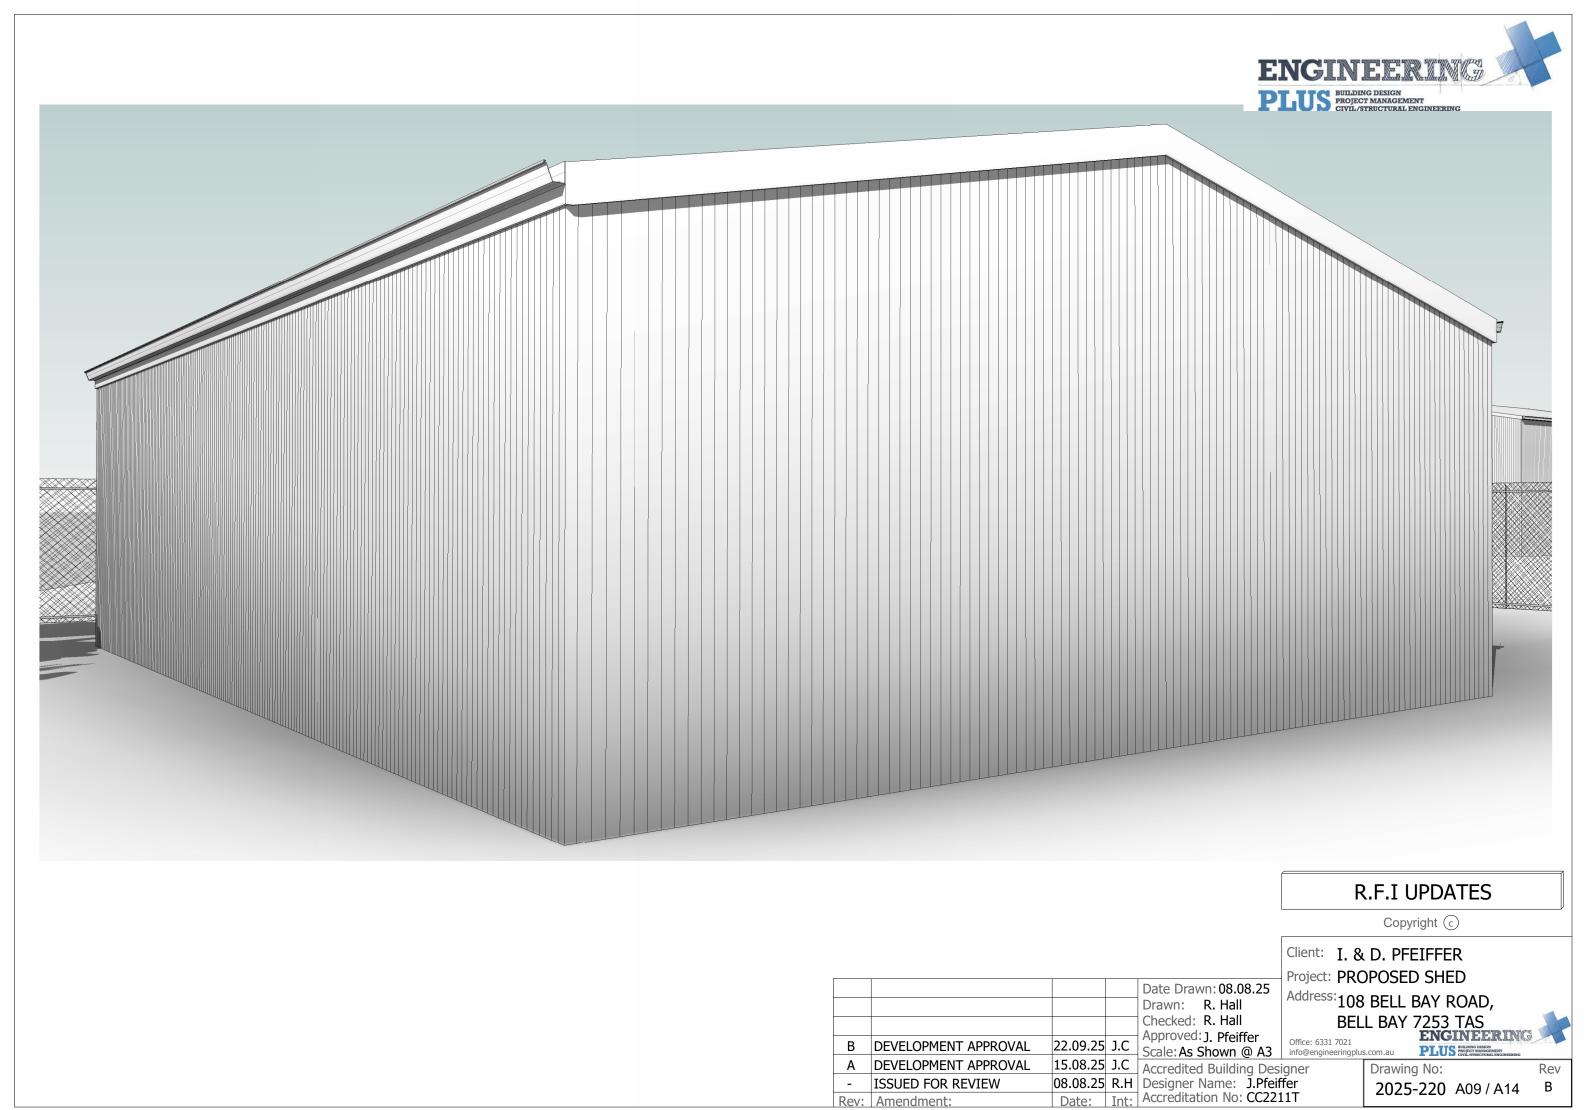





B DEVELOPMENT APPROVAL

A DEVELOPMENT APPROVAL

ISSUED FOR REVIEW

Rev: Amendment:

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Date Drawn: 08.08.25

Project: PROPOSED SHED

Address: 108 BELL BAY ROAD,
BELL BAY 7253 TAS
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22.09.25 J.C Approved: J. Pfeiffer Scale: As Shown @ A3 Office: 6331 7021 info@engineeringplus.com.au

ENGINEER IN
PLUS PROJECT MANAGEMENT
CIVIL/ATRICTURAL ENGINEER

Rev

В

15.08.25 J.C Accredited Building Designer
08.08.25 R.H Designer Name: J.Pfeiffer
Accreditation No: CC2211T

Drawn: R. Hall

Checked: R. Hall

Drawing No: 2025-220 A10 / A14



B DEVELOPMENT APPROVAL A DEVELOPMENT APPROVAL

ISSUED FOR REVIEW

Rev: Amendment:

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Client: I. & D. PFEIFFER

Project: PROPOSED SHED Date Drawn: 08.08.25

Address: 108 BELL BAY ROAD,

BELL BAY 7253 TAS
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PLUS PRIJANGMANT
PRIJANGMAN

22.09.25 J.C

15.08.25 J.C

08.08.25 R.H

Date: Int:

| Checked: K. Hall | Approved: J. Pfeiffer | Office: 6331 7021 | Info@engineeringplus.com.au | Accredited Building Designer | Draw | Designer Name: J.Pfeiffer | Accreditation No: CC2211T | 202


Drawn: R. Hall

Checked: R. Hall


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A DEVELOPMENT APPROVAL

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Address: 108 BELL BAY ROAD,

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22.09.25 J.C Approved: J. Pfeiffer Scale: As Shown @ A3 Office: 6331 7021 info@engineeringplus.com.au 15.08.25 J.C Accredited Building Designer Date: Int: Accreditation No: CC2211T

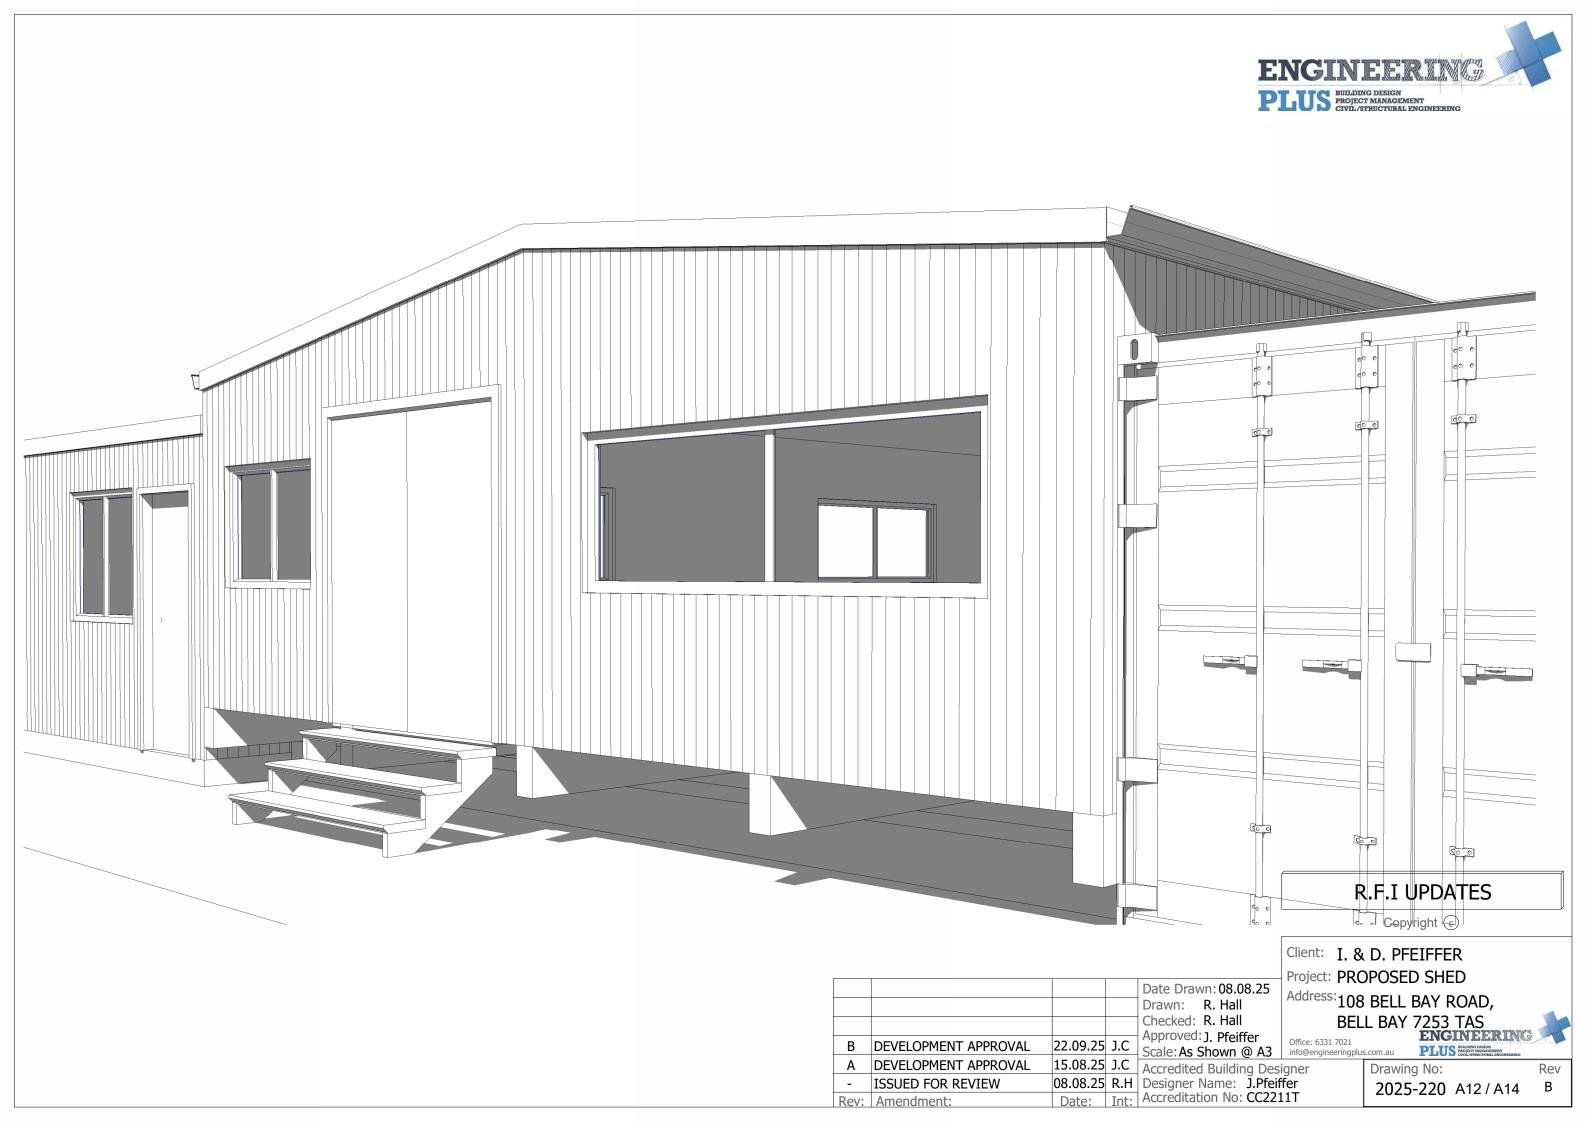Date Drawn: 08.08.25

Drawn: R. Hall

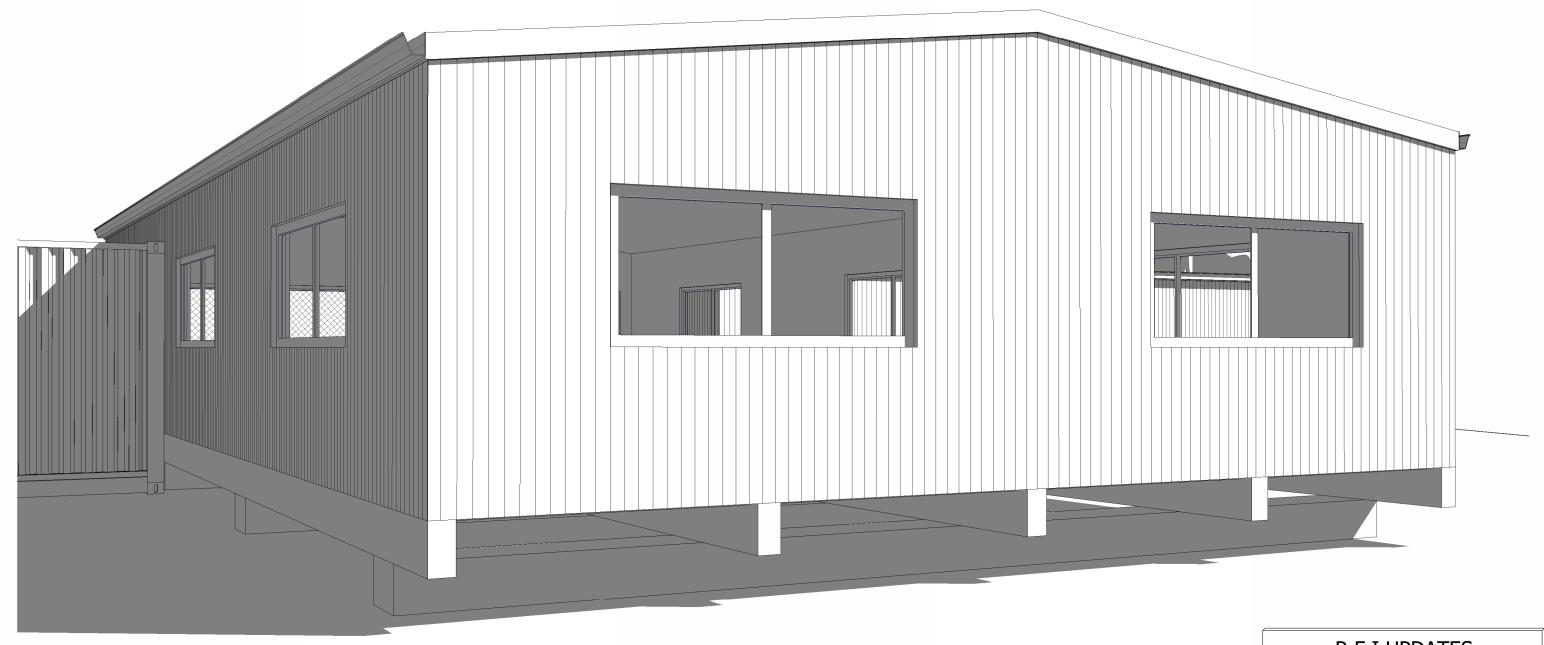Checked: R. Hall

Drawing No:

2025-220 A13 / A14

Rev

